
# Morris Basement ADU Conversion

# FFWD LLC

5608 17TH Ave NW, Ste #42 Seattle, WA 98107 ffwdllc@gmail.com

## ABBREVIATIONS:

ADDITE	.VIATIONO.						
ABV	ABOVE	FIN	FINISH	0/	OVER	TYP	TYPICAL
AFF	ABOVE FINISH FLOOR	FL	FLUSH	OC	ON CENTER	UNO	UNLESS NOTED OTHERWISE
BLDG	BUILDING	FLR	FLOOR	OG	OBSCURE GLAZING	VTO	VENT TO OUTSIDE
BLKG	BLOCKING	FOF	FACE OF FINISH	ОН	OVERHANG	W	WIDE
BM	BEAM	FOS	FACE OF STUD	P.L.	PROPERTY LINE	W	WASHER
BOT	BOTTOM	FRMG	FRAMING	PL	PLATE	W/	WITH
CIPC	CAST-IN-PLACE CONCRETE	FRZR	FREEZER	PT	POINT	WC	WATER CLOSET
Œ	CENTERLINE	FT	FOOT	PTW	PRESERVATIVE TREATED WOOD	WFC	WOOD FRAME CONSTRUCTION
CLG	CEILING	FTG	FOOTING	REBAR	REINFORCEMENT BAR	WH	WATER HEATER
CLR	CLEAR	FV	FIELD VERIFY	REFR	REFRIGERATOR	WIC	WALK-IN-CLOSET
CMD	CARBON MONOXIDE DETECTOR	FV	FOUNDATION VENT	REQD	REQUIRED	WP	WORK POINT
CO	CLEANOUT	GA	GAUGE	REQTS	REQUIREMENTS	WWF	WELDED WIRE FABRIC
CONC	CONCRETE	GB	GYPSUM BOARD	RAFT	RAFTER		
CONT	CONTINUOUS	GLB	GLULAM BEAM	RO	ROUGH OPENING		
D	DRYER	GSM	GALVANIZED SHEET METAL	R.O.W.	RIGHT-OF-WAY		
DBLE	DOUBLE	HDR	HEADER	RFT	RIP-TO-FIT		
DEMO	DEMOLISH	HGR	HANGER	RTS	RIP-TO-SLOPE		
DIA	DIAMETER	h	HIGH	RV	RIM VENT		
DN	DOWN	HT	HEIGHT	SC	SOLID CORNER		
DP	DEEP	HVAC	HEATING, VENTILATION, &	SD	SMOKE DETECTOR		
DP	DIMENSION POINT		AIR-CONDITIONING	SF	SQUARE FEET		
DS	DOWNSPOUT	IG	INSULATED GLASS	SG	SAFETY GLAZING		
DTL	DETAIL	INT	INTERIOR	SHWR	SHOWER		
DW	DISHWASHER	LAV	LAVATORY	SIM	SIMILAR		
(E)	EXISTING	LBS	POUNDS	SPEC	SPECIFICATIONS		
EA	EACH	LF	LINEAR FEET	SQ FT	SQUARE FEET		
ELEV	ELEVATION	LO	LOW	SQ IN	SQUARE INCHES		
EQ	EQUAL	MAX	MAXIMUM	STD	STANDARD		
EXT	EXTERIOR	MFR	MANUFACTURER	SUBFLR	SUBFLOOR		
EW	EACH WAY	MIN	MINIMUM	T&G	TONGUE & GROOVE		
*EW	EGRESS WINDOW	(N)	NEW	THK	THICK		
FDN	FOUNDATION	N/A	NOT APPLICABLE	TOPO	TOPOGRAPHY		
FG	FINISH GRADE	NIC	NOT IN CONTRACT	TOW	TOP OF WALL		

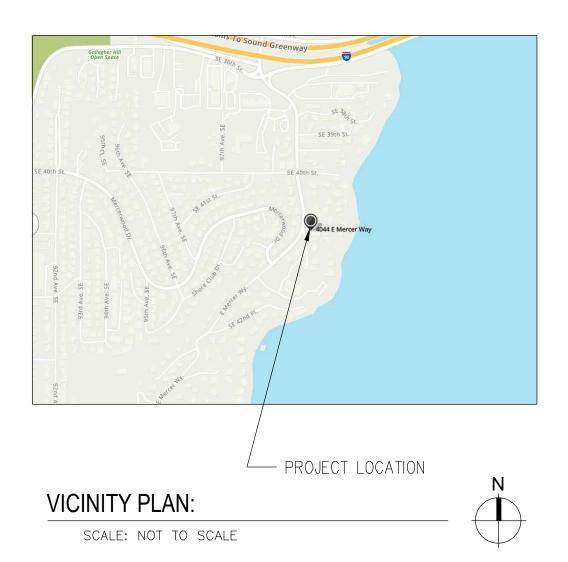

#### (E) CIRCULAR NOTE: THE SITE PLAN WAS NOT PRODUCED CONC MÉTAL STAIR— BY A LICENSED LAND SURVEYOR. THE PROPERTY LINE LOCATIONS AND SITE LANDSCAPING DRIVEWAY 7 (E) WOOD P.L. 75.00' WALKWAY7 INFORMATION ARE APPROXIMATE. 5' MIN SIDE SETBACK F P.L. 119.00' STONE STAIRS (E) CONC PARKING ELEVÁTED DRIVEWAY DECK FOR AREA -¬ ADU ENTRY ADJACENT BLDG UNDER (E) AREA — RESIDENCES/ \_/DECK FOOTPRINT LANDSCAPING area 🗕 LANDSCAPING LAWN **ENTRY** CONC AREA— DRIVEWAY -10' MIN SETBACK FROM PUBLIC RIGHT-OF-WAY & VEHICULAR ACCESS EASEMENTS ROAD EASEMENT P.L. 194.00' (E) RETAINING DRIVEWAY FOR ADJACENT RESIDENCES WALL TRÀFFIC BARRIER EXISTING SITE PLAN SCALE: 1"=20'-0"

## PROJECT CONTACT INFORMATION:

<u>OWNER:</u> Eliot Property Holdings LLC 13621 Perdido Key Dr Unit W801	<u>DESIGNER:</u> FFWD LLC 5608 17th Ave NW Ste #42 Seattle, WA 98107	CONTRACTOR: Renovation Partner LLC 5608 17th Ave NW Ste #4 Seattle, WA 98107
	Seattle, WA 98107	Seattle, WA 98107
Pensacola, FL 32507		

#### PROJECT PROPERTY INFORMATION:

PROJECT ADDRESS:
4044 E Mercer Way
Mercer Island, WA 98040

LEGAL DESCRIPTION:
LAKEHOLM ADD W 194 FT OF 7 & W 75 FT OF S 10 FT OF 6
Plat Block: 0
Plat Lot: 6-7

ASSESSOR'S TAX NUMBER:

413190-0037

LAND USE ZONE: R-9.6

PROJECT DESCRIPTION:
INTERIOR REMODEL OF EXISTING RESIDENCE WITH BASEMENT CONVERSION TO AN ATTACHED DWELLING UNIT.

## CODE INFORMATION:

APPLICABLE CODES (AS AMENDED BY WA STATE, KING COUNTY & LOCAL JURISDICTION):

2018 INTERNATIONAL RESIDENTIAL CODE (IRC)

2018 NATIONAL ELECTRICAL CODE

2018 UNIFORM PLUMBING CODE (UPC)

MECHANICAL CODE PER 2018 (IRC)

2018 INTERNATIONAL FIRE CODE

WASHINGTON STATE ENERGY CODE, 2018 EDITION (WSEC)

WASHINGTON STATE VENTILATION AND INDOOR AIR QUALITY CODE, 2018 EDITION (VIAQ)

OCCUPANCY: GROUP R-3 (SINGLE-FAMILY RESIDENTIAL)

#### NOTE:

ELECTRICAL PLAN AND SYSTEM TO BE DESIGNED BY INSTALLING CONTRACTOR AND SHALL CONFORM TO ALL APPLICABLE CODES & REGULATIONS.

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HEATING & MECHANICAL VENTUATION SYSTEM TO BE DESIGNED BY INSTALLING CONTRACTOR AND

PLUMBING PLAN AND SYSTEM TO BE DESIGNED BY INSTALLING CONTRACTOR AND SHALL CONFORM TO

HEATING & MECHANICAL VENTILATION SYSTEM TO BE DESIGNED BY INSTALLING CONTRACTOR AND SHALL CONFORM TO ALL APPLICABLE CODES & REGULATIONS.

ELECTRICAL, PLUMBING & MECHANICAL TO BE UNDER SEPARATE PERMIT SUBMITTAL.

## PROJECT SQUARE FOOTAGES:

EXISTING RESIDENCE		
(E) MAIN FLOOR AREA:	1,720 SF	
(E) FINISHED BASEMENT FLOOR AREA:	1,210 SF	
(E) ATTACHED GARAGE FLOOR AREA:	400 SF	Γ.
EXISTING TOTAL LIVING AREA:	2,930 SF	L
	_	
PROPOSED RESIDENCE		\
(E) MAIN FLOOR AREA:	1,720 SF	}
(E) FINISHED BASEMENT FLOOR AREA:	512 SF	
(E) ATTACHED GARAGE FLOOR AREA:	400 SF	)
PROPOSED BASEMENT CONVERSION TO ADU AREA:	698 SF	/
EXISTING TOTAL LIVING AREA (MAIN & ADU):	2,930 SF	)
	$\wedge$ $\wedge$ $\wedge$	/
	$\mathcal{A}$	
	(E) MAIN FLOOR AREA: (E) FINISHED BASEMENT FLOOR AREA: (E) ATTACHED GARAGE FLOOR AREA:  EXISTING TOTAL LIVING AREA:  PROPOSED RESIDENCE  (E) MAIN FLOOR AREA: (E) FINISHED BASEMENT FLOOR AREA: (E) ATTACHED GARAGE FLOOR AREA: PROPOSED BASEMENT CONVERSION TO ADU AREA:	(E) MAIN FLOOR AREA: (E) FINISHED BASEMENT FLOOR AREA: (E) ATTACHED GARAGE FLOOR AREA: (E) ATTACHED GARAGE FLOOR AREA: (E) MAIN FLOOR AREA: (E) MAIN FLOOR AREA: (E) FINISHED BASEMENT FLOOR AREA: (E) ATTACHED GARAGE FLOOR AREA:

## INDEX OF DRAWINGS:

- T1.0 GENERAL INFORMATION & SITE PLAN
- A1.0 CODE NOTES
- A2.0 MAIN FLOOR PLAN
- A3.0 BASEMENT DEMOLITION PLAN
- ..O BASEMENT FLOOR PLAN
- A5.0 SCHEDULES & DETAILS

Morris Basement ADU Conversion 4044 E Mercer Way

Mercer Island, WA 98040

Permit


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	2/20/2023	Permit Intake					
1	<b>&gt;</b> 4/10/23	Correction 01					
	Project No.:	FFWD 2210					
	Drawn:	BVF					

GENERAL INFORMATION & SITE PLAN

Sheet No:

T1.0

#### SYMBOL LEGEND:

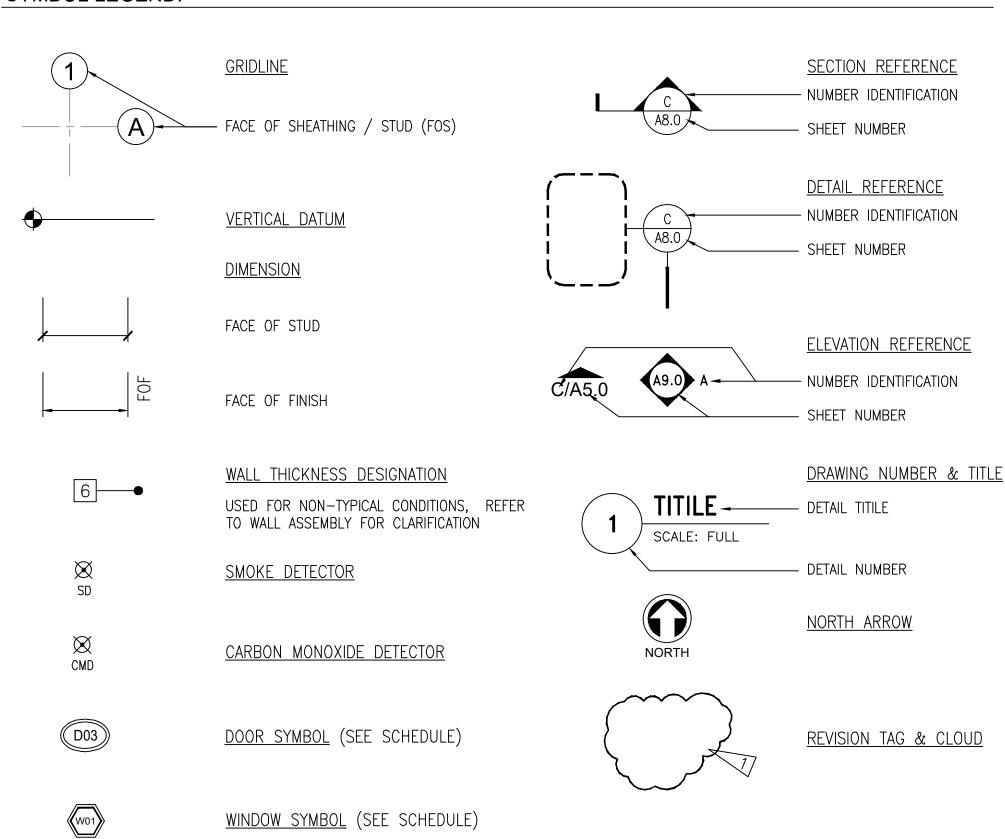

#### WHOLE HOUSE MECHANICAL VENTILATION (M1505.4):

EACH DWELLING UNIT SHALL BE EQUIPPED WITH A VENTILATION SYSTEM. THE WHOLE-HOUSE MECHANICAL VENTILATION SYSTEMS SHALL BE DESIGNED IN ACCORDANCE WITH SECTIONS M1505.4.1 THROUGH M1505.4.4.

#### M1505.4.1 SYSTEM DESIGN

THE WHOLE-HOUSE VENTILATION SYSTEM SHALL CONSIST OF ONE OR MORE SUPPLY FANS, ONE OR MORE EXHAUST FANS, OR AN ERV/HRV WITH INTEGRAL FANS, ASSOCIATED DUCTS AND CONTROLS. WHOLE-HOUSE MECHANICAL VENTILATION SYSTEM WITH SUPPLY AND EXHAUST FANS PER SECTIONS M1505.4.1.2. M1505.4.1.3, M1505.4.1.4, AND M1505.4.1.5. LOCAL EXHAUST FANS ARE PERMITTED TO SERVE AS PART OF THE WHOLE-HOUSE VENTILATION SYSTEM WHEN PROVIDED WITH THE PROPER CONTROLS PER SECTION M1505.4.2. THE SYSTEMS SHALL BE DESIGNED AND INSTALLED TO EXHAUST AND/OR SUPPLY THE MINIMUM OUTDOOR AIRFLOW RATES PER SECTION M1505.4.3 AS MODIFIED BY THE WHOLE-HOUSE VENTILATION SYSTEM COEFFICIENTS IN SECTION M1504.5.3.1 WHERE APPLICABLE. THE WHOLE-HOUSE VENTILATION SYSTEM SHALL OPERATE CONTINUOUSLY AT THE MINIMUM VENTILATION RATE DETERMINED PER SECTION M1505.4.2 UNLESS CONFIGURED WITH INTERMITTENT OFF CONTROLS PER SECTION M1505.4.3.2.

- 1. THE WHOLE-HOUSE MECHANICAL VENTILATION SYSTEM SHALL BE PROVIDED
- WITH CONTROLS THAT COMPLY WITH THE FOLLOWING: 2. THE WHOLE-HOUSE VENTILATION SYSTEM SHALL BE CONTROLLED WITH MANUAL SAFETY GLAZING IS GENERALLY REQUIRED AS FOLLOWS (IRC R308.4): SWITCHES, TIMERS OR OTHER MEANS THAT PROVIDE FOR AUTOMATIC OPERATION OF THE VENTILATION SYSTEM THAT ARE READILY ACCESSIBLE BY THE OCCUPANT: WHOLE-HOUSE MECHANICAL VENTILATION SYSTEM SHALL BE PROVIDED WITH CONTROLS THAT ENABLE MANUAL OVERRIDE OFF OF THE SYSTEM BY THE OCCUPANT DURING PERIODS OF POOR OUTDOOR AIR QUALITY CONTROLS SHALL INCLUDE PERMANENT TEXT OR A SYMBOL INDICATING THEIR FUNCTION. RECOMMENDED CONTROL PERMANENT LABELING TO INCLUDE TEXT SIMILAR TO THE FOLLOWING: "LEAVE ON UNLESS OUTDOOR AIR QUALITY IS VERY POOR." MANUAL CONTROLS SHALL BE READILY ACCESSIBLE BY THE OCCUPANT:
- 3. WHOLE-HOUSE VENTILATION SYSTEMS SHALL BE CONFIGURED TO OPERATE CONTINUOUSLY EXCEPT WHERE INTERMITTENT OFF CONTROLS AND SIZING ARE PROVIDED PER SECTION M1505.4.3.2.

#### M1505.4.3 MECHANICAL VENTILATION RATE

THE WHOLEHOUSE MECHANICAL VENTILATION SYSTEM SHALL PROVIDE OUTDOOR AIR AT A CONTINUOUS RATE AS DETERMINED IN ACCORDANCE WITH TABLE M1505.4.3(1) OR EQUATION 15-1. VENTILATION RATE IN CUBIC FEET PER MINUTE = (0.01 x)TOTAL SQUARE FOOT AREA OF HOUSE) +  $[7.5 \times (NUMBER OF BEDROOMS + 1)]$ BUT NOT LESS THAN 30 CFM FOR EACH DWELLING UNIT.

TABLE M1505.4.3(1) CONTINUOUS WHOLE-HOUSE MECHANICAL VENTILATION SYSTEM AIRFLOW RATE REQUIREMENTS

NATE INEQUINENTS									
DWELLING UNIT	NUMBER OF BEDROOMS								
FLOOR AREA	0-1	2	3	4	5 OR MORE				
(SQUARE FEET)		AIRFLOW IN CFM							
< 500	30	30	35	45	50				
501-1,000	30	35	40	50	55				
1,001-1,500	30	40	45	55	60				
1,501-2,000	35	45	50	60	65				
2,001-2,500	40	50	55	65	70				
2,501-3,000	45	55	60	70	75				
3,001-3,500	50	60	65	75	80				
3,501-4,000	55	65	70	80	85				
4,001-4,500	60	70	75	85	90				
4,501-5,000	65	75	80	90	95				

For SI: 1 square foot = 0.0929 m2, 1 cubic foot per minute =  $0.0004719 \text{ m}^3/\text{s}$ .

#### TABLE M1505.4.3(2) SYSTEM COFFFICIENT COOPER

STSTEM GOETHOLIN GSYSIEM					
	SYSTEM TYPE	DISTRIBUTED	NOT DISTRIBUTED		
BALANCE		1.0	1.25		
NOT BAL	ANCED	1.25	1.5		

## TADIE M1505 / 3/3)

INTERMITTENT WHOLE—HOUSE MECHA	NICAL VENT	TLATION RA	TE FACTORS	Sa, b
RUN-TIME PERCENTAGE IN EACH 4-HOUR SEGMENT	50%	66%	75%	100%

- 2 | 1.5 | 1.3 | 1.0 a. For ventilation system run time values between those given, the factors are permitted to be determined by interpolation.
- b. Extrapolation beyond the table is prohibited.

#### M1505.4.4 LOCAL EXHAUST RATES

FACTOR<sup>a</sup>

LOCAL EXHAUST SYSTEMS SHALL BE DESIGNED TO HAVE THE CAPACITY TO EXHAUST THE MINIMUM AIRFLOW RATE DETERMINED IN ACCORDANCE WITH TABLE M1505.4.4(1). IF THE LOCAL EXHAUST FAN IS INCLUDED IN THE WHOLE-HOUSE VENTILATION SYSTEM, IN ACCORDANCE WITH SECTION 1505.4.1, THEN THE EXHAUST FAN SHALL BE CONTROLLED TO OPERATE AS SPECIFIED IN SECTION M1505.4.2.

TABLE M1505.4.4(1)

MINIMUM REQUIRED LOCAL EXHAUST RATES FOR ONE - AND TWO-FAMILY DWELLINGS FXHALIST RATES

ADEA TO DE EVITALICAED	LAHAUSI NATES				
AREA TO BE EXHAUSTED	INTERMITTENT	CONTINUOUS			
KITCHEN	100 CFM	30 CFM			
BATHROOM - TOILET ROOMS	50 CFM	20 CFM			

## NOTE: REFER TO TABLE M1505.4.4.(2) FOR PRESCRIPTIVE EXHAUST DUCT SIZING.

## SOUND TRANSMISSION CONTROL FOR NEW DUPLEXES AND ACCESSORY DWELLING UNITS:

- FLOORS BETWEEN DWELLING UNITS (OR BETWEEN A UNIT AND A COMMON AREA) ARE REQUIRED TO HAVE SOUND DEADENING (STC = 45 MINIMUM) AND IMPACT SOUND INSULATION (IIC = 50 MINIMUM).
- WALLS BETWEEN DWELLING UNITS AND BETWEEN DWELLING UNITS AND COMMON AREAS ARE REQUIRED TO HAVE SOUND DEADENING (STC = 45 MINIMUM).

#### EMERGENCY ESCAPE AND RESCUE:

ONE WINDOW (OR DOOR) IN THE BASEMENT, A HABITABLE ATTIC, AND IN EACH BEDROOM, MUST MEET THESE REQUIREMENTS (IRC R310):

- THE MINIMUM NET CLEAR OPEN AREA IS 5.7 SQUARE FEET, (HOWEVER, OPENINGS AT GRADE FLOOR MAY BE A MINIMUM OF 5 SQUARE FEET)
- THE MINIMUM CLEAR OPEN WIDTH IS 20"
- THE MINIMUM CLEAR OPEN HEIGHT IS 24'
- THE MAXIMUM ALLOWED SILL HEIGHT IS 44"
- THE INSIDE OF THE WINDOW WELLS MUST BE A MINIMUM OF 9 SQUARE FEET IN AREA, WITH A MINIMUM 3'WIDTH, AND MUST ALLOW THE WINDOW TO OPEN ALL THE WAY. A LADDER IS REQUIRED IF THE BOTTOM OF THE WINDOW WELL IS MORE THAN 44" BELOW THE ADJACENT GROUND.
- WINDOW OPENING CONTROL DEVICES CANNOT BE LOCATED MORE THAN 70" ABOVE THE FINISHED FLOOR.

#### SAFETY GLAZING FOR DOORS & WINDOWS:

- GLAZING IN OR WITHIN 24" OF THE ARC OF A DOOR.
- GLAZING CLOSE TO THE FLOOR.
- GLAZING ADJACENT TO STAIRS AND STAIR LANDINGS.
- GLAZING NEAR WET FLOOR SURFACES.

## **ROOF VENTILATION:**

VENTILATION IS REQUIRED ON THE COLD SIDE OF ATTIC/ROOF INSULATION (IRC R806). SEE IRC R806.5 FOR UNVENTED ROOF CONSTRUCTION REQUIREMENTS

- THE VENTILATION OPENINGS MUST HAVE AT LEAST 1 SQUARE FOOT OF VENTING PER 150 SQUARE FEET OF AREA BEING VENTED. THIS CAN BE REDUCED TO 1 SQUARE FOOT OF VENTING PER 300 SQUARE FEET OF ARE TO BE VENTED IF YOU PROVIDE VENTILATORS IN THE UPPER PORTION OF THE AREA TO BE VENTED.
- THE VENT MUST HAVE AT LEAST 1" OF AIR SPACE ABOVE THE ROOF. INSULATION.
- CROSS-VENTILATION IS REQUIRED.

#### **ATTIC ACCESS:**

#### ATTIC ACCESS (IRC R807).

- THE ATTIC OPENING MUST BE AT LEAST 22" X 30".
- THE ATTIC HEADROOM MUST BE AT LEAST 30" AT THE ACCESS POINT TO THE ATTIC.

#### **CRAWL SPACE VENTILATION:**

VENTILATION IS REQUIRED IN CRAWLSPACE (IRC R408).

- CROSS-VENTILATION IS REQUIRED IN CRAWL SPACES. (SEE ALSO SRC R317.1 FOR CRAWL SPACE CLEAR HEIGHTS: 18" MINIMUM FOR JOISTS; 12" MINIMUM FOR WOOD GIRDERS WITHOUT PRESSURE TREATING.)
- THE MINIMUM AREA OF CROSS-VENTILATION OPENINGS IS 1 SQUARE FOOT PER 300 SQUARE FEET OF CRAWL SPACE AREA.

## **CRAWL SPACE ACCESS:**

## CRAWLSPACE ACCESS (IRC R408.4).

• THE MINIMUM CRAWL SPACE ACCESS OPENING IS 24" X 18" THROUGH A FLOOR OR 24" X 16" THROUGH THE WALL.

# FIRE & DRAFTSTOPS:

#### (IRC R302.11 AND I302.12)

- FIREBLOCKING AND DRAFT STOPS ARE REQUIRED IN FLOORCEILINGASSEMBLIES SO THAT THE CONCEALED SPACE DOES NOT EXCEED 1,000 SQUARE FEET.
- FIRE BLOCKS ARE REQUIRED BETWEEN CONNECTED, CONCEALED SPACES PER R302.11.

#### ROOM DIMENSION REQUIREMENTS:

#### (IRC R304 AND R305):

- THE REQUIRED CEILING HEIGHT IS 7'-0" MINIMUM FOR HABITABLE SPACES. THE MINIMUM CEILING HEIGHT FOR BATHROOMS, LAUNDRY ROOMS, BASEMENTS AND HALLWAYS IS 6 FEET 8 INCHES.
- ROOMS WITH SLOPED CEILINGS MUST MEET THE MINIMUM HEIGHT FOR AT LEAST 50% OF THE AREA (AREAS WITH CEILINGS LESS THAN 5'HIGH DON'T COUNT TOWARDS THE MINIMUM REQUIRED ROOM AREA).
- WHEN A BATHROOM HAS A SLOPING CEILING, A MINIMUM 6'-8" HEIGHT AT THE CENTER LINE OF BATHROOM FIXTURES IS REQUIRED.
- HABITABLE ROOMS SHALL BE NOT LESS THAN 70 SQUARE FEET (EXCEPT) KITCHENS).
- HABITABLE ROOMS SHALL NOT BE LESS THAN 7'-0" IN ANY HORIZONTAL DIRECTION (NOT REQUIRED FOR CLOSETS, STORAGE, KITCHENS OR UTILITY ROOMS).

#### BUILDING SEPARATION REQUIREMENTS:

FOR WALLS, OPENINGS AND EAVES CLOSE TO THE PROPERTY LINE YOU NEED TO FOLLOW THESE SEPARATION REQUIREMENTS (IRC R302.1):

• A ONE-HOUR FIRE-RATED WALL IS REQUIRED IF THE WALL IS LESS THAN 5' FROM THE PROPERTY LINE. (CARPORT POSTS DEFINE AN EXTERIOR WALL, AND THE SPACE BETWEEN POSTS IS CONSIDERED AN OPENING.) SEE THE DESCRIPTION IN THE ADJACENT BOX FOR A TYPICAL ONE HOUR RATED WALL.

FFWD LLC

Seattle, WA 98107

ffwdllc@gmail.com

5608 17TH Ave NW, Ste #42

- NO OPENINGS (DOORS AND WINDOWS) ARE ALLOWED IN WALLS LESS THAN 3' FROM THE PROPERTY LINE.
- OPENINGS IN THE WALL CAN'T EXCEED 25% OF THE TOTAL WALL AREA OF THE STORY IN WALLS THAT ARE 3' TO 5' FROM THE PROPERTY LINE.
- EAVES ARE NOT ALLOWED TO BE CLOSER THAN 2' TO THE PROPERTY LINE.
- UNDER-EAVE OR SOFFIT VENTS ARE NOT ALLOWED IN EAVES LESS THAN 5' FROM THE PROPERTY LINE; INSTEAD, SOLID BLOCKING IS REQUIRED FROM THE TOP OF THE WALL FRAMING TO THE ROOF SHEATHING.

#### GARAGE FIRE SEPARATION REQUIREMENT:

(IRC R302.5.1 AND TABLE R302.6):

- 1/2" REGULAR GYPSUM BOARD (ON THE GARAGE SIDE) IS REQUIRED AT WALLS SEPARATING THE GARAGE FROM THE DWELLING, INCLUDING GARAGES LESS THAN 3' FROM A DWELLING UNIT ON THE SAME LOT.
- WHEN A DWELLING IS ABOVE A GARAGE. THE GARAGE CEILINGS MUST BE COVERED WITH 5/8" TYPE X GYPSUM BOARD. THE STRUCTURE SUPPORTING THE DWELLING UNIT (WALLS, BEAMS AND POSTS) MUST BE COVERED WITH 1/2" REGULAR GYPSUM BOARD.
- DOORS BETWEEN A GARAGE AND A DWELLING MUST BE 1-3/8" THICK (MINIMUM) SOLID WOOD OR STEEL (SOLID OR HONEY-COMB CORE), OR BE A 20-MINUTE FIRE-RATED DOOR. THE DOOR MUST ALSO BE SELF-CLOSING.
- NO FIRE SEPARATION IS REQUIRED BETWEEN A CARPORT AND DWELLING UNIT. (CARPORTS HAVE AT LEAST TWO OPEN SIDES WITH NO PORTION OF THE DWELLING LOCATED ABOVE. SEE R309.2).

#### STAIR REQUIREMENTS:

STAIRS MUST MEET THE FOLLOWING REQUIREMENTS (IRC R311.7).

- MINIMUM OF 36' CLEAR WIDTH.
- MAXIMUM OF 7-3/4" RISER (HEIGHT OF EACH STEP).
- MINIMUM OF 10" TREAD DEPTH (A TREAD NOSING MAY BE REQUIRED).
- MINIMUM OF 6'-8" HEADROOM CLEAR.
- HANDRAIL WITH A 34"-38" HEIGHT.
- HANDRAIL GRASPING DIMENSION OF AT LEAST 1-1/4" AND NO MORE THAN 2".
- WINDING STAIR TREADS: EACH STEP MUST BE AT LEAST 10" MEASURED 12" FROM THE NARROWEST POINT AND AT LEAST 6" AT THE NARROWEST POINT.

## **GUARDRAILS & WINDOW FALL PROTECTION:**

GUARDRAILS MUST MEET THE FOLLOWING REQUIREMENTS (IRC R312).

- A GUARD (GUARDRAIL) IS REQUIRED FOR WALKING SURFACES 30" ABOVE ADJACENT GRADE OR FLOOR.
- MINIMUM OF 36" FOR THE GUARD HEIGHT.
- MAXIMUM OF 4" CLEAR SPACE BETWEEN INTERMEDIATE RAILS IN GUARDS.
- FALL PROTECTION IS REQUIRED FROM OPERABLE WINDOWS MORE THAN 6 FEET ABOVE GRADE, WHEN LOWEST EDGE OF WINDOW OPENING IS WITHIN 24" OF FINISHED FLOOR OF THE ROOM IN WHICH THE WINDOW IS LOCATED.

## SMOKE ALARM:

THE FOLLOWING RULES APPLY FOR SMOKE ALARMS (IRC R314).

- YOU MUST INSTALL SMOKE ALARMS IN NEW CONSTRUCTION AND EXISTING 4/10/23 | Correction 01 DWELLING UNITS.
- THE ALARMS MUST BE POWERED BY INTERCONNECTED BUILDING WIRING, AND HAVE BATTERY BACK-UP IN NEW CONSTRUCTION AND NEW ADDITIONS.
- SMOKE ALARMS MAY BE BATTERY—POWERED IF YOU ARE ALTERING OR REPAIRING A DWELLING UNIT, EXCEPT WHEN YOU CAN INSTALL INTERCONNECTED BUILDING WIRING WITHOUT REMOVING THE INTERIOR FINISHES.
- ALARMS ARE REQUIRED IN SLEEPING ROOMS, OUTSIDE SLEEPINGAREAS, AND ON OTHER FLOORS (INCLUDING BASEMENTS). AN ALARM OUTSIDE OF THE BEDROOMS MUST BE CLEARLY AUDIBLE IN THE BEDROOMS. SHOW THE ALARM LOCATION ON YOUR PLANS.
- HEAT ALARM: A HEAT DETECTOR OR HEAT ALARM RATED FOR AMBIENT OUTDOOR TEMPERATURES AND HUMIDITY IS REQUIREDFOR NEW GARAGES ATTACHED TO OR LOCATED UNDER NEW OR EXISTING DWELLINGS.

## CARBON MONOXIDE ALARM:

INSTALL CARBON MONOXIDE ALARMS ACCORDING TO THESE REQUIREMENTS (SEE IRC

- YOU MUST INSTALL CARBON MONOXIDE ALARMS IN NEW CONSTRUCTION AND IN EXISTING DWELLING UNITS.
- CARBON MONOXIDE ALARMS ARE REQUIRED OUTSIDE SLEEPINGAREAS, AND ON ALL FLOORS (INCLUDING BASEMENTS). SHOW THE ALARM LOCATION(S) ON YOUR PLANS

CODE NOTES

Morris Basement

ADU Conversion

Mercer Island, WA 98040

Permit

Set

2/20/2023 | Permit Intake

Project No.:

Drawn:


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FFWD 2210


BVR

4044 E Mercer Way

Sheet No:



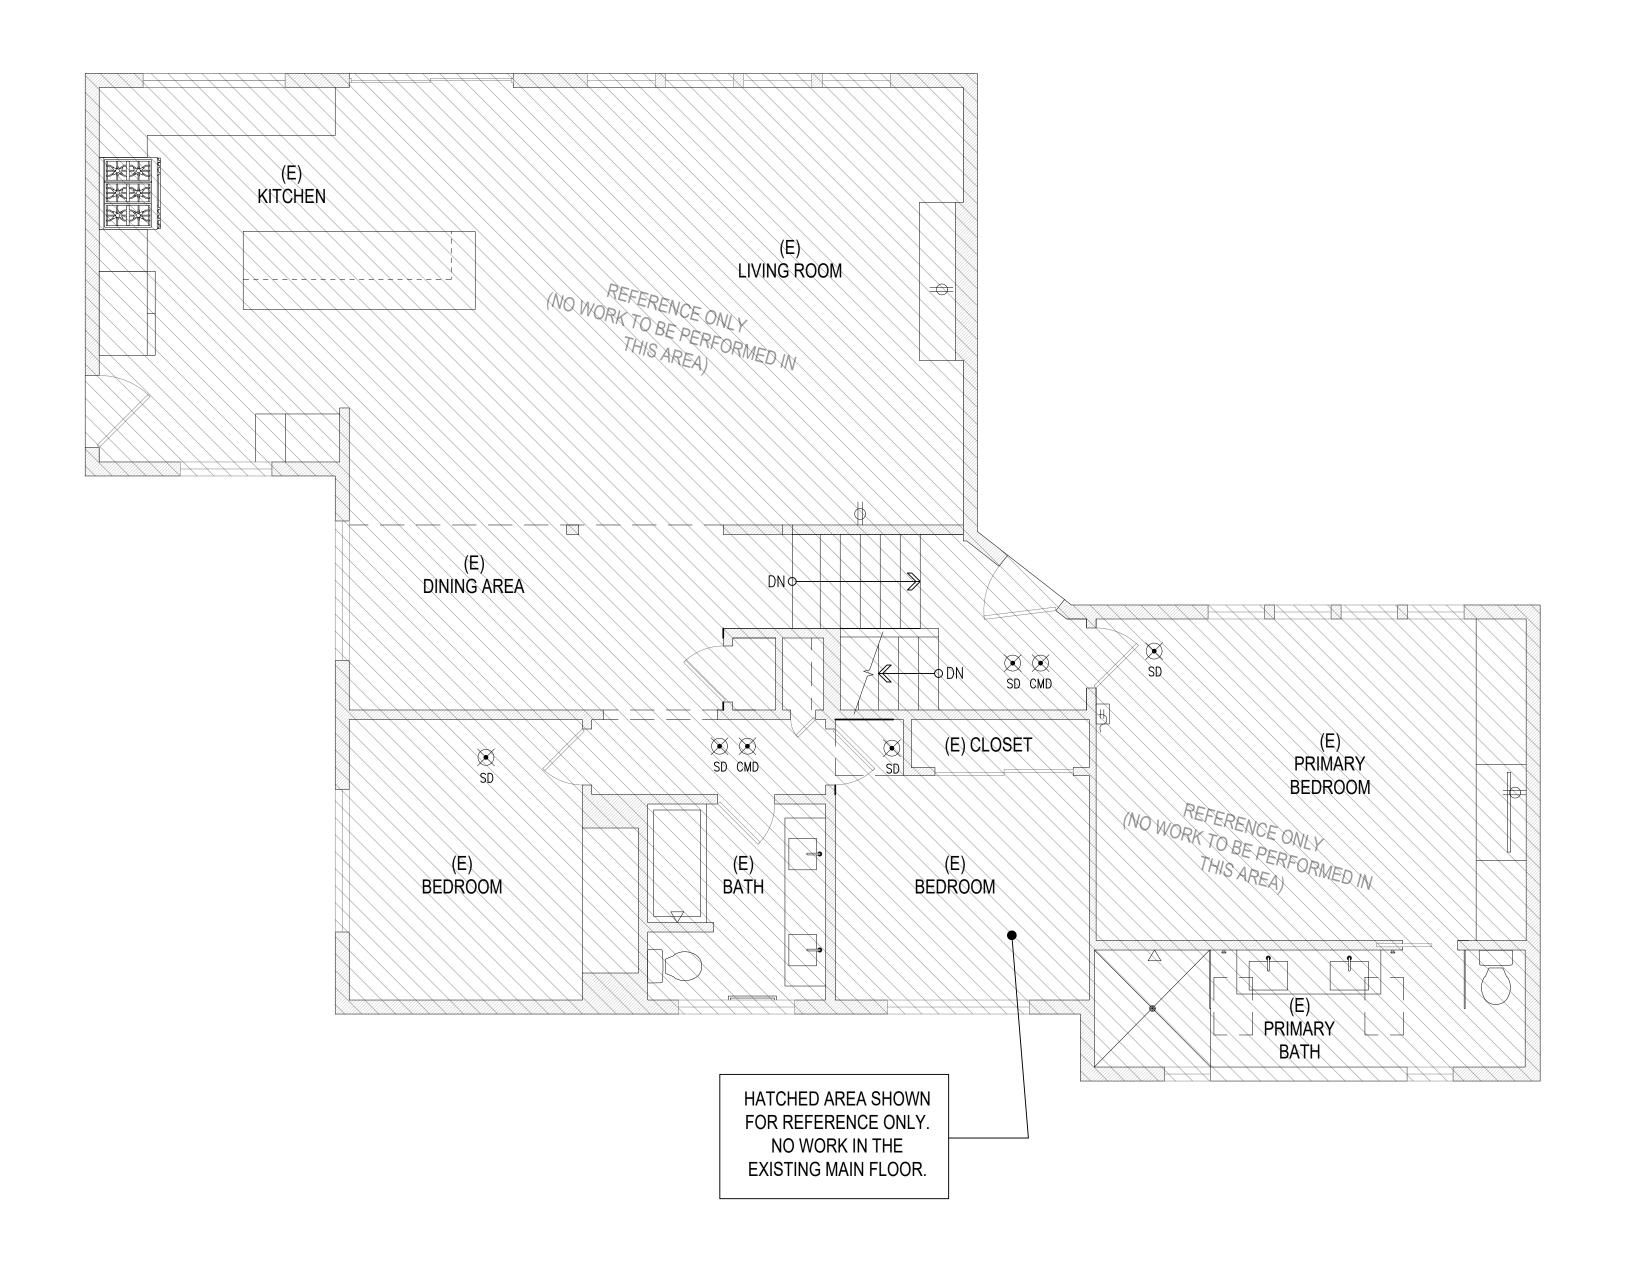

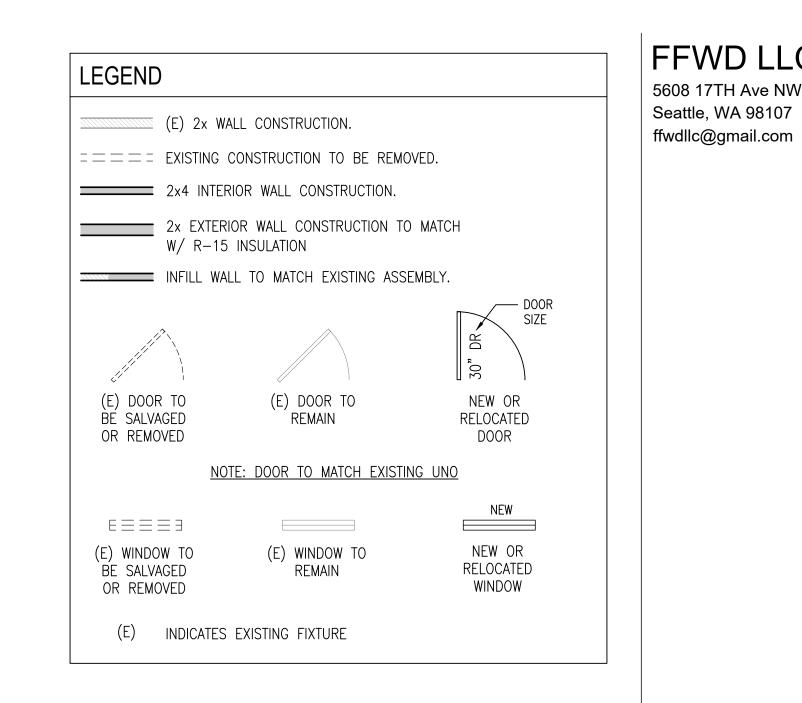

Morris Basement ADU Conversion

FFWD LLC

Seattle, WA 98107

5608 17TH Ave NW, Ste #42

4044 E Mercer Way Mercer Island, WA 98040

Permit Set


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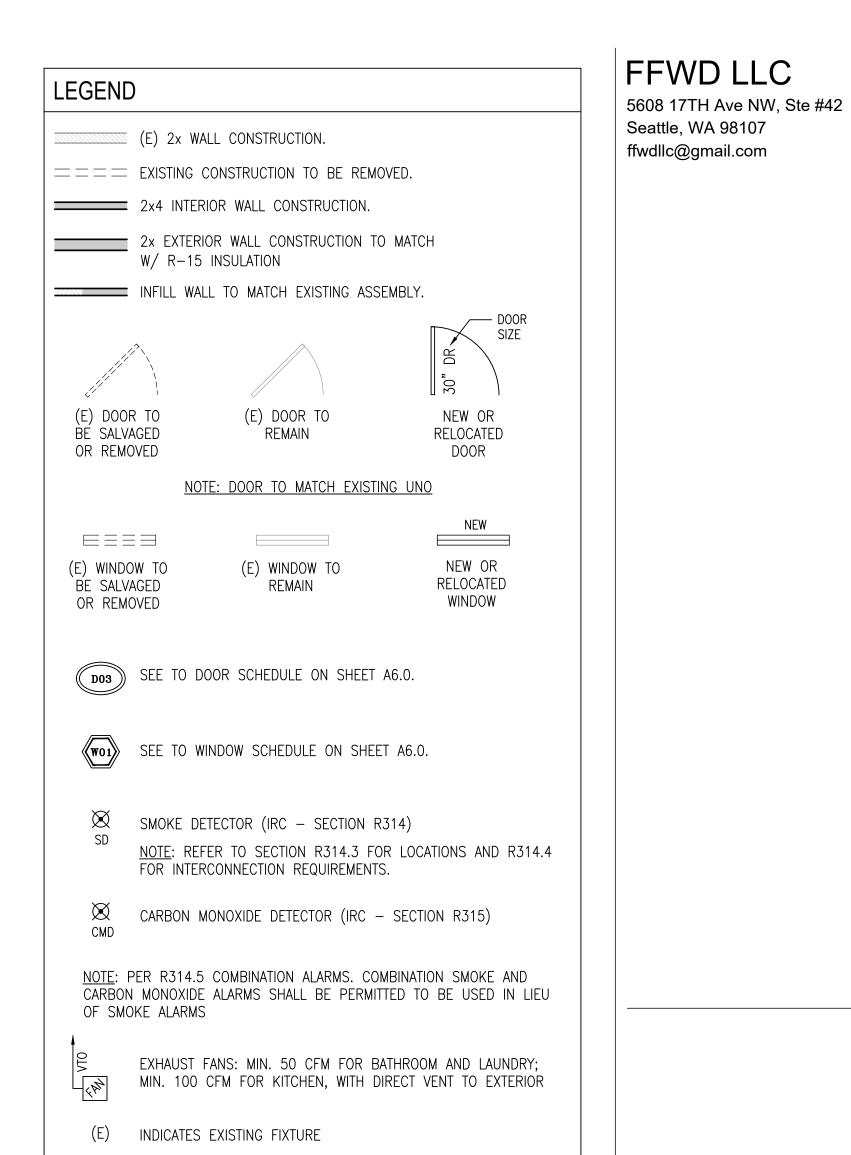
MAIN FLOOR PLAN

Sheet No:

Drawn:





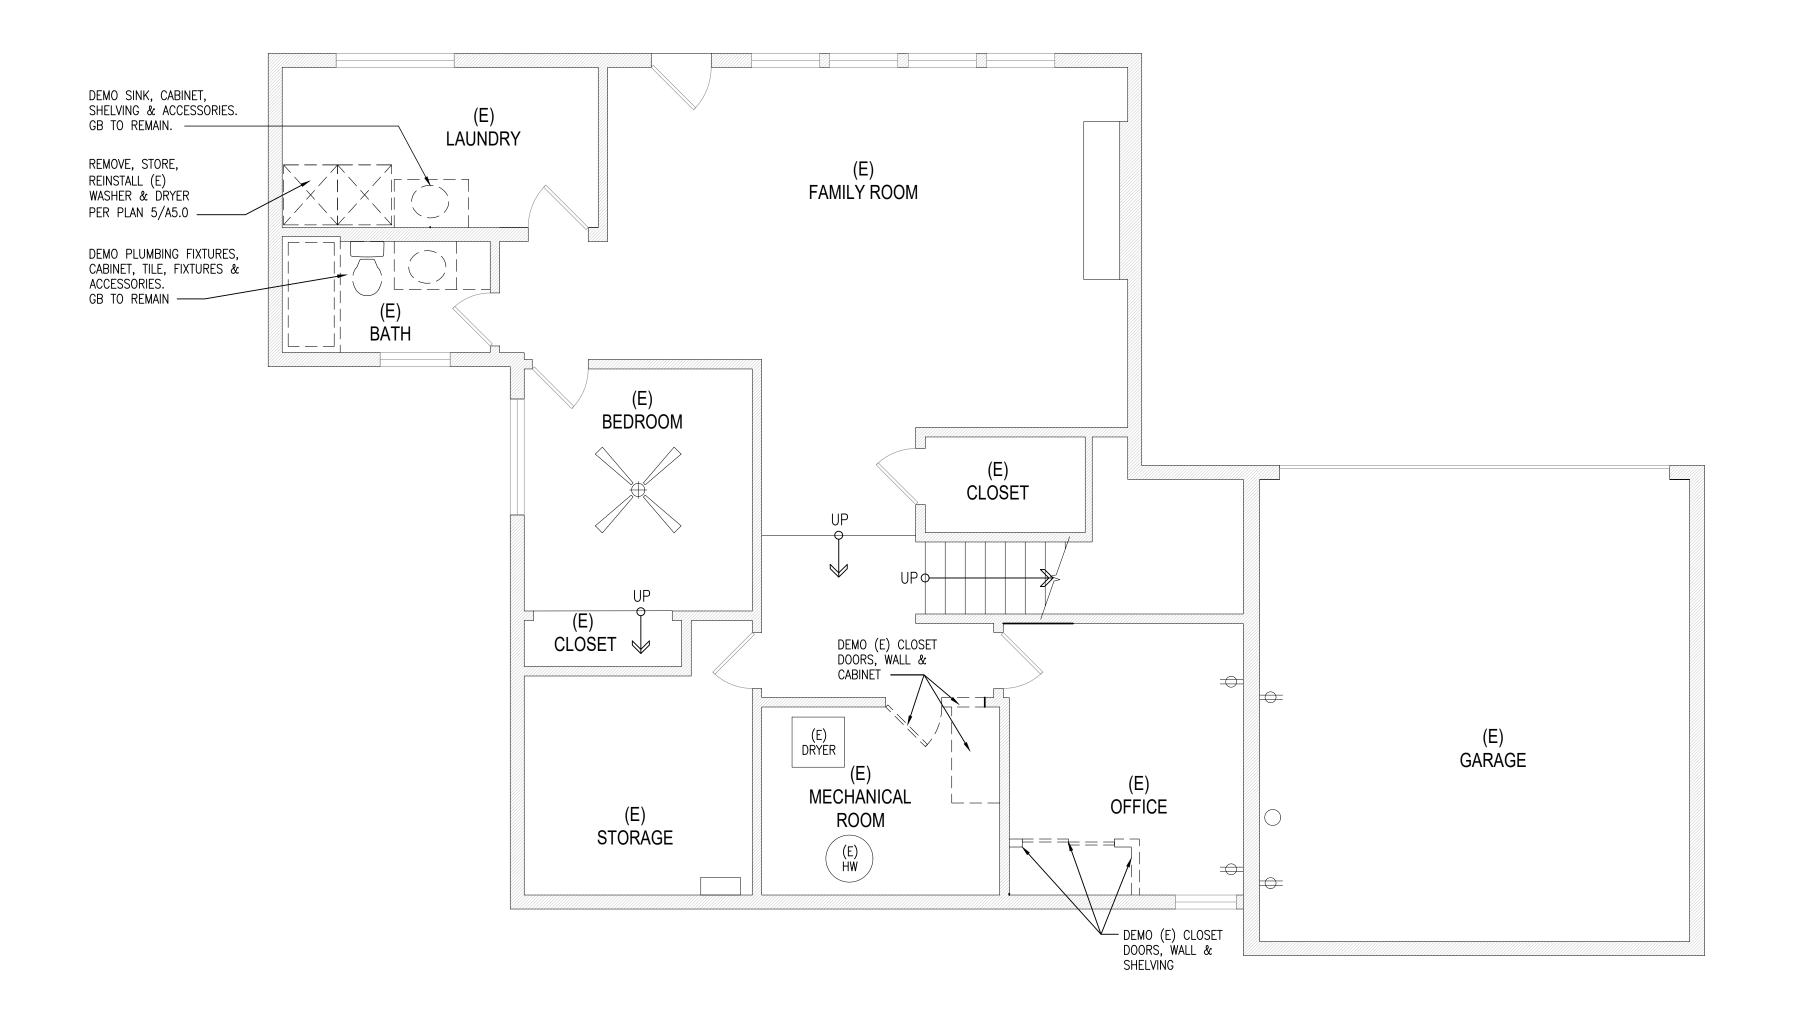

Morris Basement ADU Conversion

4044 E Mercer Way Mercer Island, WA 98040

> Permit Set

Date: Description:

2/20/2023 Permit Intake

4/10/23 Correction 01


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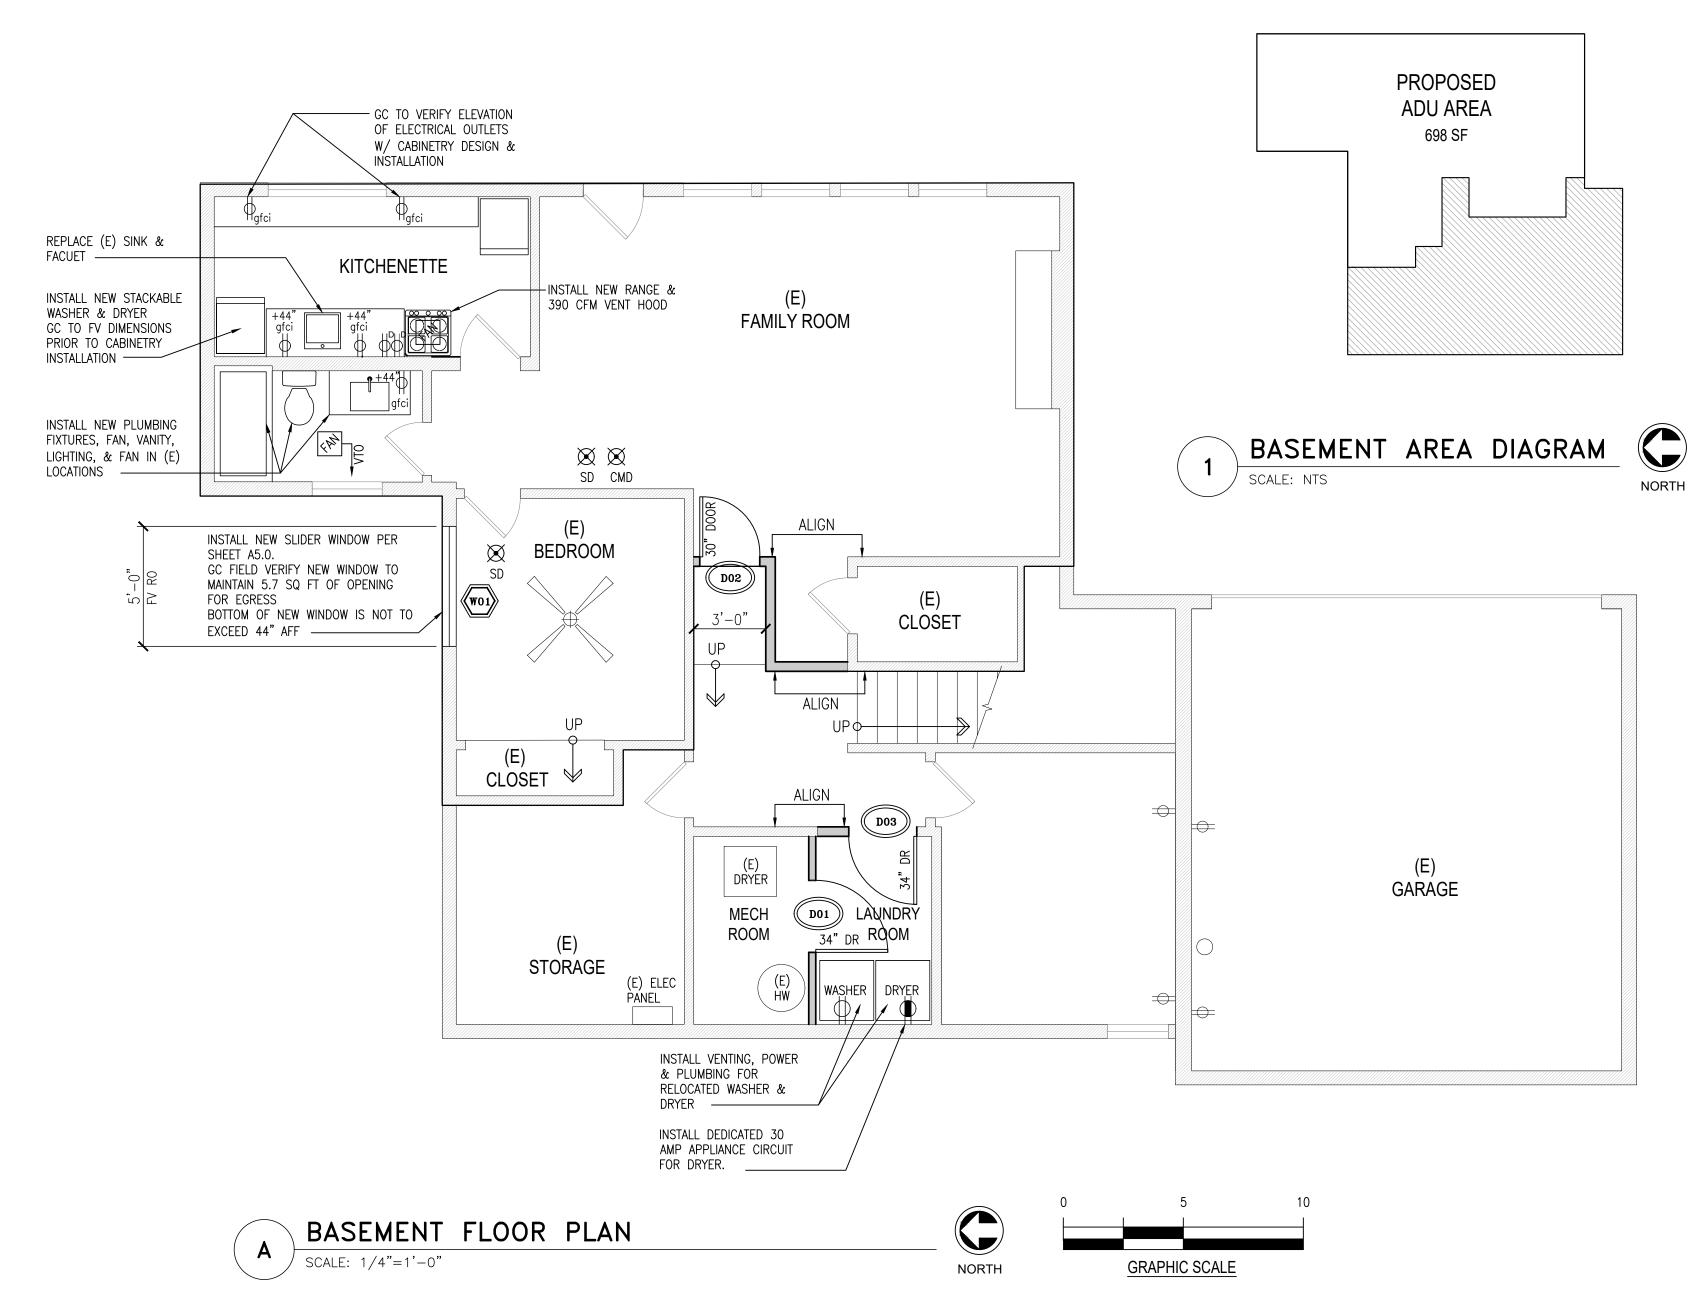
Drawn: BVR


BASEMENT DEMOLITION PLAN


Sheet No:

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NOTE: NFPA 72 CHAPTER 29 MONITORED FIRE ALARM SYSTEM TO BE INSTALLED THROUGHOUT RESIDENCE PER COMI AND NFPA

STANDARDS. (A SEPARATE FIRE PERMIT IS REQUIRED.)

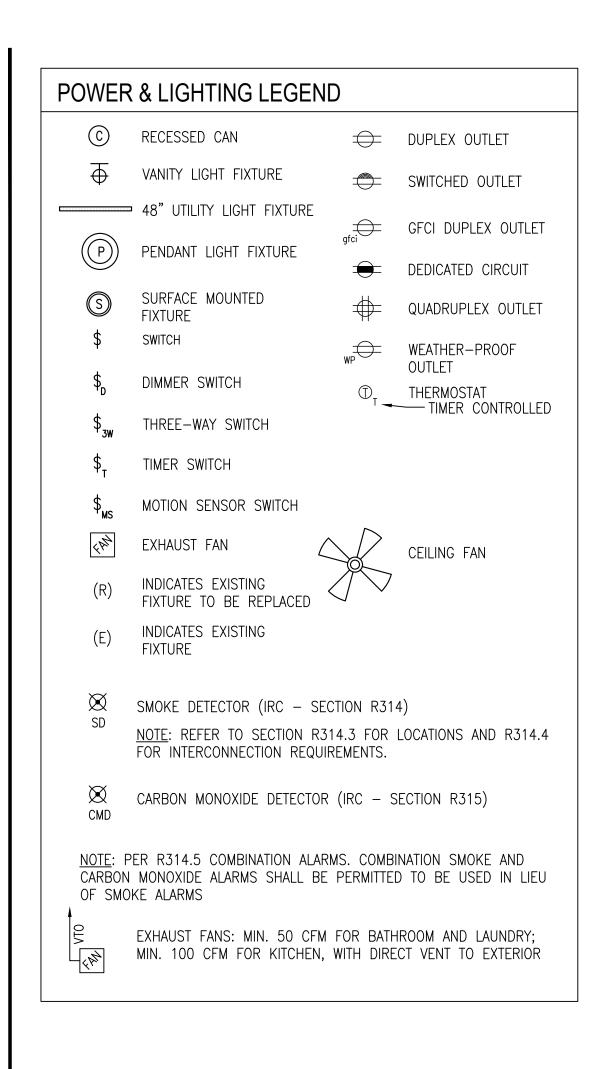Morris Basement ADU Conversion

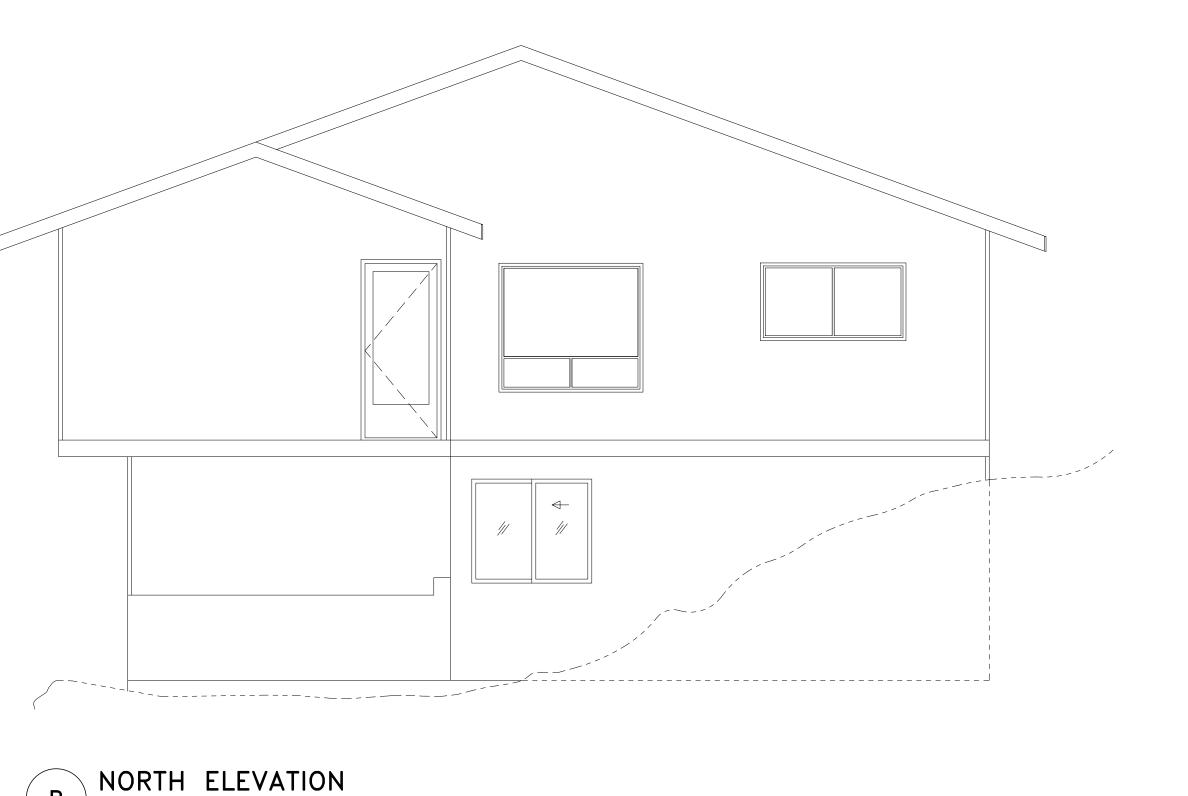4044 E Mercer Way Mercer Island, WA 98040

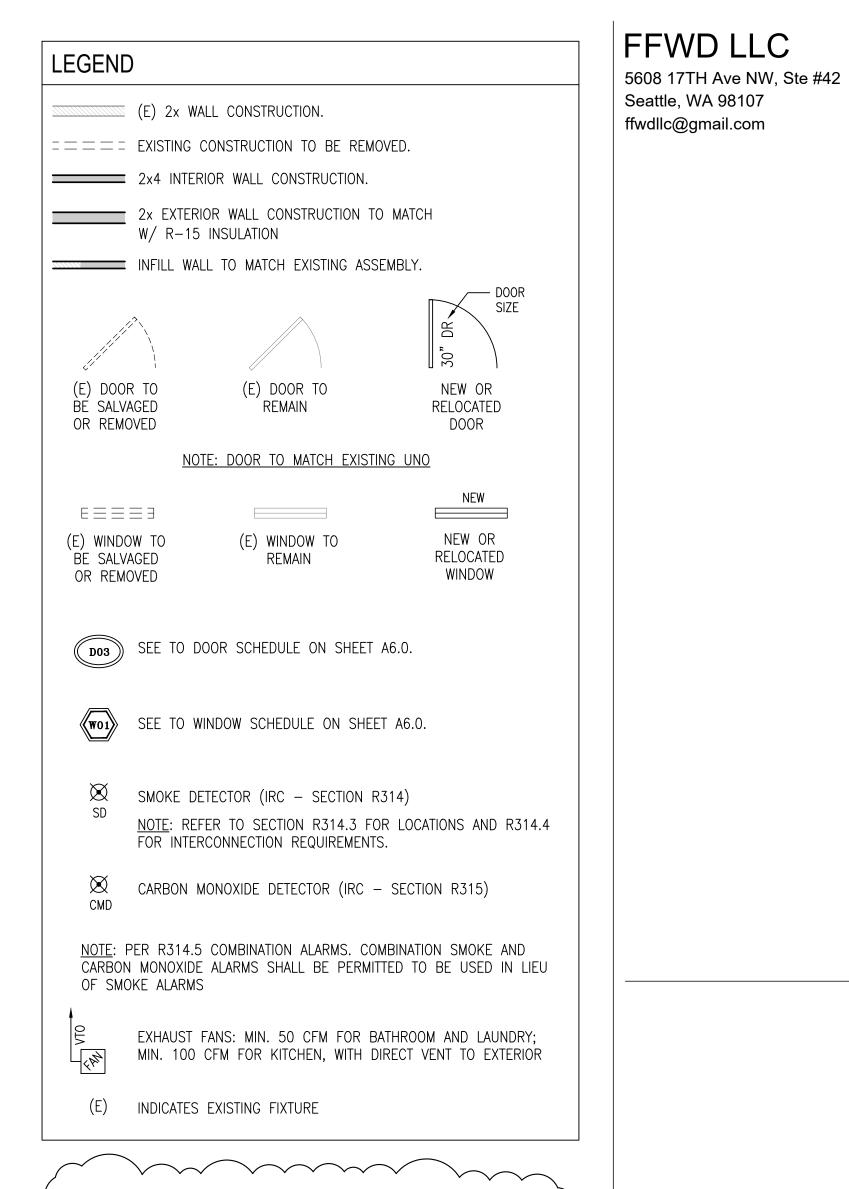Permit
Set

Date: Description:
2/20/2023 Permit Intake
4/10/23 Correction 01


Project No.: FFWD 2210

BASEMENT FLOOR PLAN

Sheet No:

Drawn:

A4.0

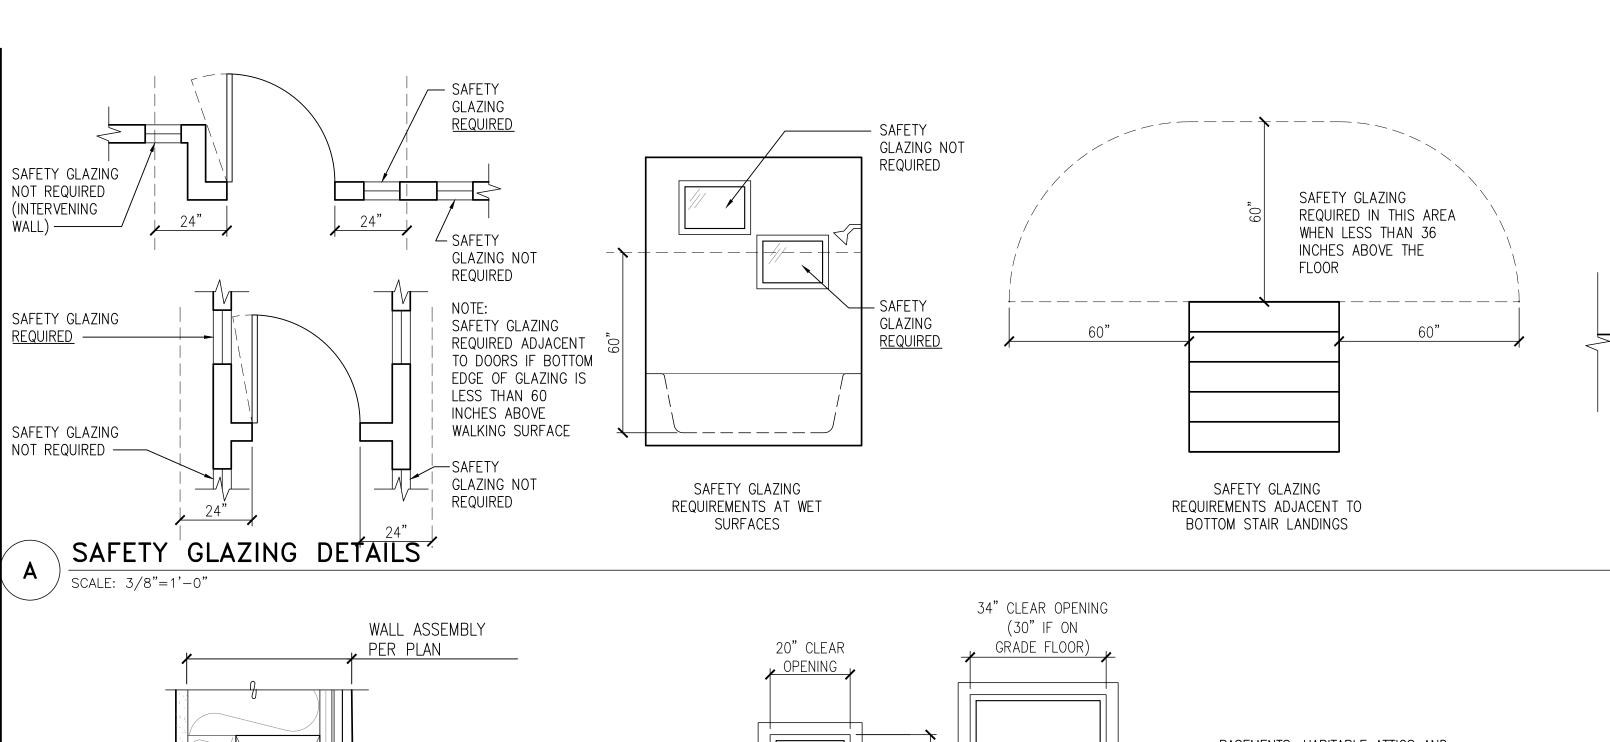

-SHEET METAL

-JOINT SEALANT

-JOINT SEALANT

- WINDOW

-JOINT SEALANT

WALL ASSEMBLY

PER PLAN

- WINDOW

WALL ASSEMBLY

PER PLAN

HEAD FLASHING

HEADER

PER PLAN-

JOINT SEALANT-

INSULATION

FRAMING

PER PLAN-

PER SECTION -

JOINT SEALANT

OUTLINE OF

SILL &

GB —

INSULATION

PER SECTION —

SILL DETAIL

 $\int SCALE: 3"=1'-0"$ 

CASING TRIM-

SILL BELOW—

JAMB DETAIL

SCALE: 3"=1'-0"

HEAD DETAIL

SCALE: 3"=1'-0"

BASEMENTS, HABITABLE ATTICS AND EVERY SLEEPING ROOM SHALL NOT MINIMUM REQUIRED HAVE LESS THAN ONE OPERABLE NET CLEAR EMERGENCY ESCAPE AND RESCUE OPENING AREA IS OPENING. WHERE BASEMENTS 5.7 S.F. CONTAIN ONE OR MORE SLEEPING ROOMS, AN EMERGENCY ESCAPE AND OPENINGS AT THE RESCUE OPENING SHALL BE GRADE FLOOR MAY REQUIRED IN EACH SLEEPING ROOM. BE REDUCED TO EMERGENCY ESCAPE AND RESCUE 5 S.F. OPENINGS SHALL OPEN DIRECTLY MINIMUM SIZE MINIMUM SIZE INTO A PUBLIC WAY, OR TO A WINDOW FOR 20" WINDOW COURT OR YARD THAT OPENS TO A CLEAR WIDTH FOR 24" CLEAR PUBLIC WAY. FINISH FLOOR

## MINIMUM EMERGENCY EGRESS OPENING REQUIREMENTS SCALE: 1/2"=1'-0"

FLASHING @ HEAD FLASHING OVERLAPS JAMB ---UNDER BLDG FLASHING PAPER HEADER ROUGH IN OPENING \$ILL FLASHING - FLASHING SILL FLASHING - WINDOW OVER BLDG FRAME PAPER STEP #2 STEP #3 STEP #1

#### FLASHING OF EXTERIOR WALL OPENINGS:

INDIVIDUALLY FLASH ALL EXTERIOR OPENINGS FOR FIXTURE SUCH AS WINDOWS, DOORS, AND VENTS TO MAKE THEM WATERRPROOF. FLASHING MATERIAL SHALL BE MOISTOP BY MANFUL. SEALANT SHALL BE COMPATIBLE AND APPROVED BY MANFUL. IN HIGH WIND AREAS W.R. GRACE ICE & WATER SHIELD SHALL BE USED, OVER SOLID BACKING. FLASHING MATERIAL AT LEAST 9" WIDE SHALL BE APPLIED IN A WEATHER BOARD FASHION, BEGINNING WITH THE SILL WITH A STRIP LONG ENOUGH TO PROJECT BEYOND THE JAMB FLASHING TO BE APPLIED. THE TWO JAMB FLASHING ARE THEN APPLIED WITH SUFFICIENT LENGTH TO EXTEND BEYOND THE SILL FLASHING. AND WITH THE SAME DISTANCE AT THE TOP.

FOR FIXTURES WITHOUT NAIL-ON FLANGES, THE FLASHING SHALL BE 12" MIN. WIDTH AND EXTEND INTO THE ROUGH FRAME AT THE SILL AND JAMB.

FOR NAIL-ON FLANGE FIXTURE, INSTALL BY PRESSING FLANGE POSITIVELY INTO A CONTINUOUS BEAD OF SEALANT WHICH EXTENDS AROUND THE BOTTOM AND SIDES OF THE FIXTURE.

APPLY THE TOP HORIZONTAL FLASHING LAST, WITH SUFFICIENT LENGTH TO EXTEND BEYOND THE JAMB

FLASHING. OVERLAP AND SEAL AGAINST THE THE TOP NAILING FLANGE OR G.S.M. HEAD FLASHING WITH A CONTINUOUS BEAD OF SEALANT.

APPLY REMAINING WALL SHEATHING PAPER IN A WEATHERBOARD FASHION WITH THE SILL FLASHING LAPPING OVER THE TOP AND THE HEAD AND JAMB FLASHING BELOW.

## TYPICAL WINDOW OPENING FLASHING REQUIREMENTS SCALE: NOT TO SCALE

GLAZING NOT REQUIRED : SAFETY SAFETY GLAZING GLAZING REQUIRED -<u>REQUIRED</u> 60"

SAFETY GLAZING

STAIRS & RAMPS

REQUIREMENTS ADJACENT TO

SAFETY GLAZING

REQUIREMENTS ADJACENT TO

BOTTOM STAIR LANDINGS

DOOR SIZE

HEIGHT

6'-8"

WIDTH

3'-0"

2'-6"

SAFETY

GLAZING NOT

REQUIRED ---

SAFETY GLAZING IN WINDOWS:

REQUIRED IF THE INDIVIDUAL PANEL MEETS ALL THE FOLLOWING REQUIREMENTS:

A. EXPOSED INDIVIDUAL PANEL IS GREATER THAN 9 SQ FT B. BOTTOM EDGE OF GLAZING IS LESS THAN 18 INCHES FROM FLOOR C. TOP EDGE OF THE GLAZING IS MORE THAN 36 INCHES ABOVE

D. A WALKING SURFACE WITHIN 36 INCHES, MEASURED HORIZONTALLY, FROM THE GLAZING

EXCEPTIONS

I. DECORATIVE GLAZING II. A HORIZONTAL RAIL CAPABLE OF RESISTING 50 LBS PER LINER FOOT OF FORCE W/OUT MAKING CONTACT WITH THE GLAZING IS INSTALLED ON ACCESSIBLE SIDE OF GLAZING 34 TO 38 INCHES ABOVE THE WALKING SURFACE.

1. WHERE HORIZONTAL RAIL CAPABLE OF RESISTING 50 LBS PER LINEAR FOOT OF FORCE W/OUT MAKING CONTACT WITH THE GLAZING IN IS INSTALLED ON THE ACCESSIBLE SIDE OF THE GLAZING 34 TO 38 INCHES ABOVE THE WALKING SURFACE.

SAFETY GLAZING AT STAIRS & RAILINGS:

2. GLAZING MORE THAN 36 INCHES HORIZONTALLY FROM THE WALKING

SURFACE IS NOT REQUIRED TO BE SAFETY GLAZING.

#### DOOR SCHEDULE U-FACTOR ROUGH OPENING TOTAL (MIN OR BETTER QUANTITY MATERIAL NOTES AREA WIDTH | HEIGHT NFRC-CERTIFIED) 3'-2" | 6'-10.5" | FIBERGLASS 20.00 0.30 TBD FIRE RATED, INSULATED & SELF CLOSER 6'-8" | 2'-8" | 6'-10.5" | WOOD TBD 2'-10" | 6'-8" | 3'-0" | 6'-10.5" | WOOD TBD 1

SPECIFICATION: (A) ALL VERTICAL FENETRATION TO HAVE U-FACTOR = 0.30 MAX OR BETTER;

> ADU Conversion 4044 E Mercer Way

FFWD LLC

Seattle, WA 98107

ffwdllc@gmail.com

5608 17TH Ave NW, Ste #42

Mercer Island, WA 98040

Morris Basement

Permit Set

Description: 2/20/2023 Permit Intake FINISH 1 4/10/23 Correction 01

> FFWD 2210 Project No.: BVR Drawn:

## WINDOW TYPES SCALE: 1/4"=1'-0"

IDEN

D01

D02

D03

NOTES:

(1)

SINGLE PANEL

SINGLE PANEL

SINGLE PANEL

	WINDOW SCHEDULE									
	7.405		SIZE		ROUGH OPENING			TOTAL		DECORPTION
IDEN	TYPE	MATERIAL	WIDTH	HEIGHT	WIDTH	HEIGHT	QUANTITY	AREA	SPEC	DESCRIPTION
					TOTA	AL QUANTITY	1	81.00 SF	TOTAL A	AREA (SQUARE FEET)
NOTES:									SPECIFIC/	CATION:
(1)									(A)	

SCHEDULES AND DETAILS

Sheet No: